RE-ROOFING AT NORTHSIDE HOMES for the PALATKA HOUSING AUTHORITY PALATKA, FLORIDA 32177

BOARD OF COMMISSIONERS

WILLIE MAE THOMAS DR. GILBERT EVANS, JR. DR. SHARON SPELL JAMES NESHEWAT CHRISTINE BOLDEN SHARON WILLIAMS

(ACTING) PRESIDENT **CHAIRPERSON** VICE-CHAIRPERSON COMMISSIONER COMMISSIONER COMMISSIONER



PARCEL IDENTIFICATION NUMBERS:

37-10-26-6850-3430-0000

42-10-27-6850-3210-0000

42-10-27-6850-3220-0010

42-10-27-6850-3100-0010 42-10-27-6850-2880-0300

42-10-27-6850-2890-0300

42-10-27-6850-2710-0100

42-10-27-6850-3110-0010

42-10-27-6850-2870-0100

42-10-27-6850-3200-0000

42-10-27-6850-3120-0010 42-10-27-6850-2860-0800

42-10-27-6850-3130-0110

42-10-27-6850-2850-1100

OWNER:

PALATKA HOUSING AUTHORITY

P.O. BOX 1277

PALATKA, FL 32178


SITE ADDRESS:

400 N 16th St

PALATKA, FL 32177

SCOPE OF WORK:

- REMOVE EXISTING SHINGLE ROOF AND UNDERLAYMENT
- REPAIR DAMAGED ROOF SHEATHING
- INSTALL NEW METAL ROOFING SYSTEM, UNDERLAYMENT AND **GUTTERS**
- PRESSURE WASH EXISTING STRUCTURE

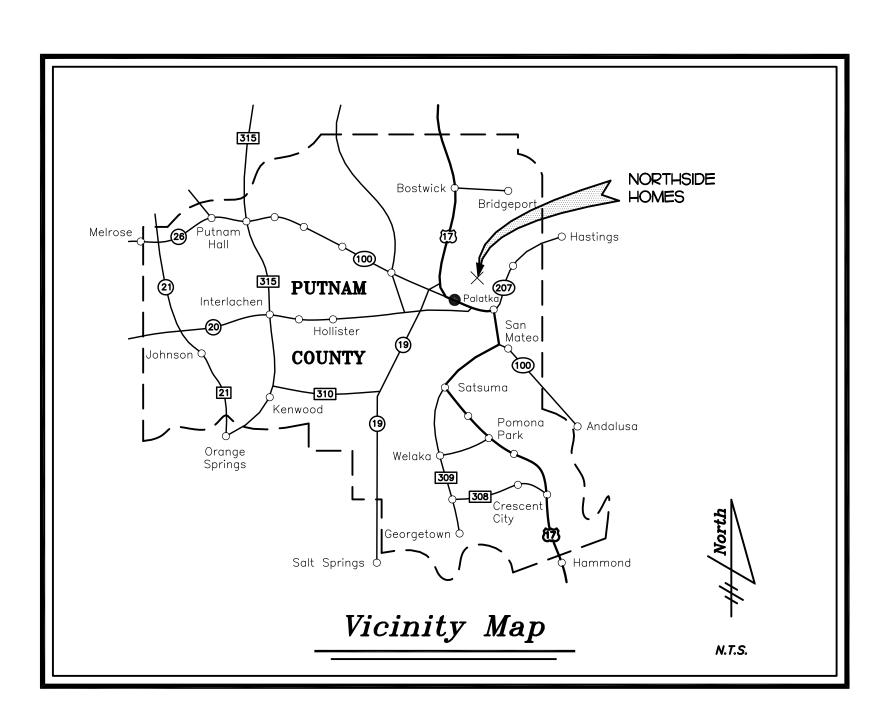



INDEX TO THE DRAWINGS

COVER SHEET

ARCHITECTURAL

ABBREVIATIONS AND LEGENDS AND SITE PLANS

NORTHSIDE HOMES SITE PLAN ROOF PLANS AND ELEVATIONS

ROOF PLANS AND ELEVATIONS

ROOF PLANS AND ELEVATIONS ROOF PLAN AND ELEVATIONS

A-2.0 DETAILS AND NOTES

STATEMENT OF COMPLIANCE:

To the best of my knowledge, these construction documents are in compliance with criteria set forth in the 8th edition of the Florida Building Code and Florida Statutes.

BID SET

Seal/Signature:

1-6-25 Scale: AS NOTED

Ol6ZO3


JCK

MATERIAL LEGEND	GENERAL NOTES		LIST OF ABBREVIATIONS (ALPHABETIZED)					REVISION BY
PARTITION		TO THE AREAS INDICATED IN THESE DRAWINGS. ALL WORK WILL HE APPROPRIATE LICENSED SUBCONTRACTORS IN STRICT	A.B. ANCHOR BOLT ABV. ABOVE ACC. ACCESS ACOUS. ACOUSTICAL	C.T. CERAMIC TILE CTR. COUNTER C.W. COLD WATER C.FT. CUBIC FEET	G. GAS GA. GAUGE GAL. GALLON GALV. GALVANIZED	MIR. MIRROR MISC. MISCELLANEOUS MLD. MOLDING M.O. MASONRY OPENING MOD. MODULAR	RVS. REVERSE S. SOUTH, SWITCH S4S. SURFACED FOUR SIDES	
PARTITION WALL WITH SOUND BATTS	2. ALL WORK IS TO BE EXECUTED UNDER DIRECT GENERAL CONTRACTOR SHALL VERIFY ALL SITE CO WITH THE APPROPRIATE SUBCONTRACTORS. HANGIN ASSEMBLY OR ANY OTHER STRUCTURAL COMPONEN	SUPERVISION OF A CERTIFIED GENERAL CONTRACTOR. THE NDITIONS, DIMENSIONS, AND COORDINATE ALL OPENINGS AND INSERTS IG DEVICES SHALL BE INSTALLED SO AS NOT TO OVERLOAD THE TS. IT IS THE CONTRACTOR'S SOLE RESPONSIBILITY TO DETERMINE	A/C AIR CONDITIONING A.D. AREA DRAIN ADD. ADDENDUM ADH. ADHESIVE ADJ. ADJUSTABLE A.F.F. ABOVE FINISHED FLOOR AGG. AGGREGATE A.H.U. AIR HANDLING UNIT	C.YD. CUBIC YARD D. DRAIN D.A. DOUBLE ACTING DBL. DOUBLE DEMO. DEMOLISH, DEMOLITIC DEP. DEPRESSED	G.B. GRAB BAR G.C. GENERAL CONTRACT(OR) GD. GRADE G.I.T. GLAZED INTERIOR TILE GKT. GASKET GL. GLASS, GLAZING N GOVT. GOVERNMENT G.P. GALVANIZED PIPE	MOD. MODULAR MOV. MOVABLE MR MOISTER RESISTANT MT. MOUNTED MTL. MATERIAL MULL. MULLION MICRO MICROWAVE	S4S. SURFACED FOUR SIDES SAN. SANITARY S.B.C. SOUTHERN BUILDING CODE SC. SOLID CORE S.C. SEALED CONCRETE SCH. SCHEDULED SCN. SCREEN S.D. STORM DRAIN	
BATT INSULATION	ERECTION PROCEDURE AND SEQUENCE TO ENSURE THE SAFETY OF THE BUILDING, ITS COMPONENTS, AND ALL PRESENT ON THE SITE. DIMENSIONS: ALL DIMENSIONS AND ELEVATIONS SHOWN ON THE DRAWINGS SHALL BE VERIFIED BY THE CONTRACTOR		ALUM. ALUMINUM ALT. ALTERNATE AMP. AMPERE ANC. ANCHOR, ANCHORAGE	DEPT. DEPARTMENT DET. DETAIL D.F. DRINKING FOUNTAIN D.H. DOUBLE HUNG DIA. or \$\phi\$ DIAMETER	GRN. GRANITE GR.V. GRAVITY ROOF VENTILATOR G.S. GRAVEL STOP GT. GROUT G.W.B./GYP. BD GYPSUM WALLBOARD	N. NORTH N/A NOT APPLICABLE NAT. NATURAL N.I.C. NOT INCLUDED IN THIS CO	SEC. SECTION SERV. SERVICE SGL. SINGLE SH SHELF	
RIGID INSULATION	TO INSURE THE PROPER INTERFACING WITH EXISTING CONDITIONS. IF ANY CONFLICT OCCURS BETWEEN ANY PART OF THESES DOCUMENTS THE CONTRACTOR IS TO NOTIFY THE ARCHITECT IMMEDIATELY. IF THE ARCHITECT IS NOT AFFORDED THE OPPORTUNITY TO CLARIFY OR MODIFY ANY CONFLICTS, THE CONTRACTOR ASSUMES RESPONSIBILITY FOR RESOLVING ANY PROBLEMS WHICH MAY HAVE DEVELOPED.		ANL. ANGLE ANOD. ANODIZED A.P. ACCESS PANEL APX. APPROXIMATE ARCH. ARCHITECT/ARCHITECTURAL ASB. ASBESTOS	DIAG. DIAGONAL DIS. DISPENSER DIFF. DIFFUSER DIM. DIMENSION DIR. DIRECTORY	H HIGH H.B. HOSE BIB H.C. HOLLOW CORE or HANDICAPPE	NO. NUMBER NOM NOMINAL N.R. NOISE REDUCTION N.T.S. NOT TO SCALE	SHTH. SHEATHING SIM. SIMILAR S.J. SAW JOINT SKY. SKYLIGHT SL. SLEEVE	CKG
FINISHED WOOD	RESPONSIBILITY, IT IS THE CONTRACTOR'S SOLE R TO INSURE THE SAFETY OF THE BUILDING AND ITS	ESPONSIBILITY TO DETERMINE ERECTION PROCEDURE AND SEQUENCE COMPONENT PARTS DURING ERECTION. THIS INCLUDES BUT IS NOT	ASPH. ASPHALT ATTN ATTENTION A.T. ACOUSTICAL TILE AUTO. AUTOMATIC	DIV. DIVISION D.L. DEAD LOAD DN. DOWN DO. DITTO DP. DAMPROOFING	H.D. HEAVY DUTY HDW. HARDWARE H.F.E. HALON FIRE EXTINGUISHER H.M. HOLLOW METAL HOR. HORIZONTAL	OA. OVERALL O.A. OUTSIDE AIR OBS. OBSCURE O.C. ON CENTER	SP. SOUNDPROOFING SPEC. SPECIFICATION SPK. SPEAKER SQ. SQUARE SQ. FT. SQUARE FEET	CRG ARCHITECTS / PALATKA, INC. 216A ST. JOHNS AVE.
DIMENSIONAL LUMBER	LIMITED TO THE ADDITION OF WHATEVER TEMPORARY BRACING, GUYS, OR TIE DOWNS THAT MAY BE NECESSARY. SUCH MATERIAL SHALL BE REMOVED AND SHALL REMAIN THE PROPERTY OF THE CONTRACTOR AFTER COMPLETION OF THE PROJECT. IT IS THE CONTRACTOR'S RESPONSIBILITY TO DETERMINE THE MEANS AND METHODS REQUIRED TO ACHIEVE THE INTENT OF THESE DRAWINGS.		BAL BALANCE BATT BATTEN BRG BEARING BD. BOARD	DP.M. DAMPROOFING MEME DR. DOOR D.S. DOWNSPOUT DTL. DETAIL DW. DRYWALL D.W. DUMBWAITER	RANE HR. HOUR HT. HEIGHT HGT. HEATING HVAC. HEATING, VENTILATING AND AIR CONDITIONING H.W. HOT WATER	O.D. OUTSIDE DIAMETER OFF. OFFICE OH. OVERHEAD O.H. OVERHANG O.J. OPEN-WEB JOIST OPG. OPENING	SS. SERVICE SINK S.S. STAINLESS STEEL ST. STEEL STD. STANDARD STO. STORAGE STR. STRUCTURAL	PALATKA, FL 32177 A A 0 0 0 2 6 0 4 p. 386-325-0213 f. 386-328-1401
WOOD BLOCKING	CONFLICTS: WHERE CONFLICTS OCCUR BETWEEN THE SPECIFICATIONS, REFERENCED CODES, NOTES ,AND WORKING DRAWINGS, THE MOST STRINGENT REQUIREMENTS SHALL APPLY. IT IS THE CONTRACTOR'S SOLE RESPONSIBILITY TO NOTIFY THE ARCHITECT IMMEDIATELY OF ANY CONFLICTS FOR DIRECTION. COORDINATION: GENERAL CONTRACTOR SHALL COORDINATE ALL OPENINGS AND INSERTS WITH THE APPROPRIATE SUBCONTRACTORS ACCORDING TO THE PLANS. SEE SHOP DRAWINGS FOR ALL SUPPORTING STRUCTURES AND INSERTS REQUIRED BY THE VARIOUS BUILDING SYSTEMS. ALL SUPPORT STRUCTURES AND HANGING DEVICES SHALL BE INSTALLED SO AS NOT TO OVERLOAD THE STRUCTURE OR ANY STRUCTURAL COMPONENT. THE CONTRACTOR SHALL BE RESPONSIBLE FOR THE SAFETY OF THE STRUCTURE AND ITS OCCUPANTS.		BEL. BELOW BETN. BETWEEN BIT. BITUMINOUS B.J. BAR JOIST B.JT. BED JOINT	D/W DISHWASHER DWG. DRAWING DWR. DRAWER	HWD HARDWOOD I.D. INSIDE DIAMETER ILK. INTERLOCK	OP.H. OPPOSITE HAND OPP. OPPOSITE PC.C PRECAST CONCRETE	SUB SUBCONTRACTOR SUSP. SUSPENDED SYM SYMMETRICAL SYS. SYSTEM	BID SET
EARTH C.M.U. WALL			BLDG. BUILDING BLK. BLOCK BLKG. BLOCKING BM. BEAM B.M. BENCH MARK B.M.U. BRICK MASONRY UNIT BOTT. BOTTOM	E. EAST EA. EACH E.B. EXPANSION BOLT E.F. EACH FACE E.J. EXPANSION JOINT EL. ELEVATION ELV ELEVATOR	IN. INCHES INCL. INCLUDE INSUL INSULATION INT. INTERIOR INV. INVERT	PED. PEDESTAL PERF. PERFORATE (D) PERI. PERIMETER PERM. PERMANENT PERP PERPENDICULAR P.F.L. POUNDS PER LINEAL FOOT PFD. PREFINSIED	T.G.,TEM. TEMPERED GLASS	S AND SITE
CAST-IN-PLACE CONCRETE	SUBMITTALS, THE REVIEW OF VARIOUS SUBMITTALS SYSTEMS ENGINEER OF RECORD WILL BE TO: VER BY A QUALIFIED PERSON, THAT THE PREPARER HAS CONSTRUCTION DOCUMENTS. NO DETAILED REVIEW	BY THE VARIOUS SUBCONTRACTORS AND PRE-ENGINEERED RIFY THAT THE SUBMITTALS HAVE BEEN FURNISHED AND PREPARED S UNDERSTOOD THE INTENT OF THE DESIGN AND THE WILL BE MADE BY THE ARCHITECT AND ENGINEER. THE GENERAL DRAWINGS INDICATING THAT A THOROUGH REVIEW WAS	B.PL. BEARING PLATE BR BEDROOM BRG. BEARING BRK. BRICK B.S. BOTH SIDES B.W. BOTH WAYS BSMT. BASEMENT B.T.U. BRITISH THERMAL UNIT B.U.R. BUILT-UP ROOF	ELEC. ELECTRIC EMER. EMERGENCY ENC. ENCLOSE (URE) ENGR. ENGINEER ENT. ENTRANCE E.P. ELECTRIC PANELBOA EQ. EQUAL EQUIP. EQUIPMENT EST. ESTIMATE E.W. EACH WAY	KD KNOCK DOWN KO KNOCK OUT K.S. KNEE SPACE	P.G. PLATE GLASS PK. PARKING PL. PLATE P.L. PROPERTY LINE PLAS. PLASTER PNL. PANEL PR. PAIR PRES. PRESSURE PREENG. PRE-ENGINEERED PREFAB. PRE-FABRICATED	TEG TONGUE E GROOVE TEB TOP AND BOTTOM THK. THICKNESS THR. THRESHOLD THRU. THROUGH T.J. TOOLED JOINT TKBD. TACKBOARD T.O.W. TOP OF WALL TPTN. TOILET PARTITION T.P.D. TOILET PAPER DISPENSER	EVIATIONS NDS AND MAPS
REINFORCED VERTICAL CMU CELL	ENGINEER WILL REVIEW THE SHOP DRAWING SUBMIT- SUBMITTAL WILL BE REJECTED, ADDITIONAL REVIEW	FAL ONCE AND IF FOUND NOT TO BE IN CONFORMANCE, THE S CAN BE PERFORMED FOR THE COST BURDEN DIRECTLY RELATED ON, THE CONTRACTOR IS TO SUBMIT ALL COLOR RELATED	CAB. CABINET CAP. CAPACITY C.B. CATCH BASIN CER. CERAMIC CEM. CEMENT C.FL. COUNTERFLASHING C.F. CUBIC FEET	E.W.C. ELECTRIC WATER CO E.W.H. ELECTRIC WATER HE EXCA. EXCAVATE EXH. EXHAUST EXIST. EXISTING EXP. EXPOSED EXT. EXTERIOR		PREP. PREPARE PROJ. PROJECTOR PSC. PRESTRESSED CONCRETE PSF. POUND PER SQUARE FOOT PSI. POUNDS PER SQUARE INCH P.T. PRESSURE TREATED P.T.D. PAPER TOWEL DISPENSER PTN. PARTITION	T.S. TUBULAR STEEL T.V. TELEVISION TYP. TYPICAL T (FEET) H UC. UNDERCUT UNF. UNFINISHED UL UNDERWRITERS LABORATORY	ABBRE
	GRAPHIC SYMBOLS		C.G. CORNER GUARD CHAM. CHAMFER CHG. CHANGE	FAB FABRICATE F.A. FIRE ALARM F.B. FACE BRICK	L.H. LEFT HAND LINO LINOLEUM LIN. FT. LINEAL FEET	PWD. PLYWOOD PVC. POLYVINYL CHLORIDE	U.N.O. UNLESS NOTED OTHERWISE UR. URINAL	
	1 DOOR MARK	C DETAIL NO. SECTION/DETAIL TARGET A-6 SHEET NO.	C.I. CAST IRON CIR. CIRCLE C.J. CONSTRUCTION JOINT C.JT. CONTROL JOINT CK. CAULKING	F.B.C., FLORIDA BUILDING C F.B.O. FUNISHED BY OTHER F.D. FLOOR DRAIN F.E. FIRE EXTINGUISHER	L.L.H. LONG LEG HORIZONTAL L.L.V. LONG LEG VERTICAL LMS. LIMESTONE	Q.T. QUARRY TILE QTR. QUARTER QTY. QUANTITY	V. VINYL VAC. VACUUM VAR. VARNISH V.C.T. VINYL COMPOSITION TILE	N A A A A A A A A A A A A A A A A A A A
	A WALL MARK	D ELEVATION NO. ELEVATION REFERENCE SHEET NO.	© CENTER LINE C.L. CHAIN LINK CLG. CEILING CLOS CLOSET CLR. CLEAR	F.F. FACTORY FINISHED F.E.C. FIRE EXTINGUISHER (F.F.E. FINISHED FLOOR ELE F.F.L. FINISHED FLOOR LINE F.G. FIXED GLASS	VATION LTL. LINTEL E LVR. LOUVER LW. LIGHTWEIGHT	R. RISER R.A. RETURN AIR RAD. RADIUS R.C.P. REINFORCED CONCRETE PIR	VERT. VERTICAL VEST. VESTIBULE VOL. VOLUME VENT VENTILATION PE	
	WINDOW MARK	A-9 SHEET NO. ELEVATION REFERENCE	C.M.T. CERAMIC MOSAIC TILE C.M.U. CONCRETE MASONRY UNIT COL. COLUMN CONC. CONCRETE CONC. BLK CONCRETE BLOCK	FGL. FIBERGLASS FIG FIGURE FIN. FINISHED FIXT. FIXTURE F.JT. FLUSH JOINT FLSHG. FLASHING	LW.C. LIGHTWEIGHT CONCRETE M. METER MACH. MACHINE MAR.T. MARBLE THRESHOLD	R.D. ROOF DRAIN RECEP. RECEPTACLE RECT. RECTANGULAR REF. REFERENCE, REFRIGERATOR REFL REFLECTIVE	W.C. WATER CLOSET)MES TY
	H 101 ROOM SPACE NUMBER EXIT LIGHT (ILLUMINATED)	D SECTION NO. A-9 SHEET NO. WALL OR PARTIAL BUILDING SECTION	CONC. FL CONCRETE FLOOR COND. CONDUIT CONN. CONNECTION CONST. CONSTRUCTION CONT. CONTINUOUS CONTR. CONTRACT (CONTRACTOR)	FLR. FLOOR FLUR, FLUORESCENT FND. FOUNDATION FP. FIREPROOF FPL. FIREPLACE	MAS. MASONRY MAX. MAXIMUM M.B. MARKER BOARD MBR. MEMBER M.C. MEDICINE CABINET	REG REGISTER REINF. REINFORCED REQ. REQUIRED RES. RESILIENT RET. RETURN REV. REVISION OR REVISED	WD. WOOD W.G. WIRE GLASS W.H. WALL HUNG W/H WATER HEATER WDW. WINDOW W.I. WROUGHT IRON	DE HC
	N NORTH ARROW (TRUE)	D SECTION NO D CROSS OR BUILDING SECTION	CORR. CORRIDOR CPT. CARPET CSK. COUNTERSINK CSMT. CASEMENT C.ST. CAST STONE C.T. CERAMIC TILE	FR. FRAME (D) (ING) F.S. FULL SIZE FT FOOT FTG. FOOTING FUR. FURRED FUT. FUTURE F.V. FIELD VERIFY	MED. MEDIUM MTL. METAL MECH. MECHANICAL MFR. MANUFACTURE (R) M.H. MANHOLE M.H.O. MAGNETIC HOLD OPEN MIN. MINIMUM	RFG. ROOFING RF.H. ROOF HATCH RH RIGHT HANDED R.L. RAIN LEADER RM. ROOM R.O. ROUGH OPENING R.O.W. RIGHT OF WAY	W.M. WIRE MESH W/O WITHOUT W.P. WATERPROOF (ING) W.R. WATER REPELLENT WT. WEIGHT W.W.F. WELDED WIRE FABRIC W.W.M. WELDED WIRE MESH	NORTHSI JSING AUT ATKA, FL.
								G AT A HOU PAL
								ROOFIN ALATK/

- ALL RIGHTS RESERVED - DO NOT REPRODUCE

Seal/Signature:

Date: I-6-25
Scale: AS NOTED
Drawn: JCK
Job: Ol6ZO3
Sheet:

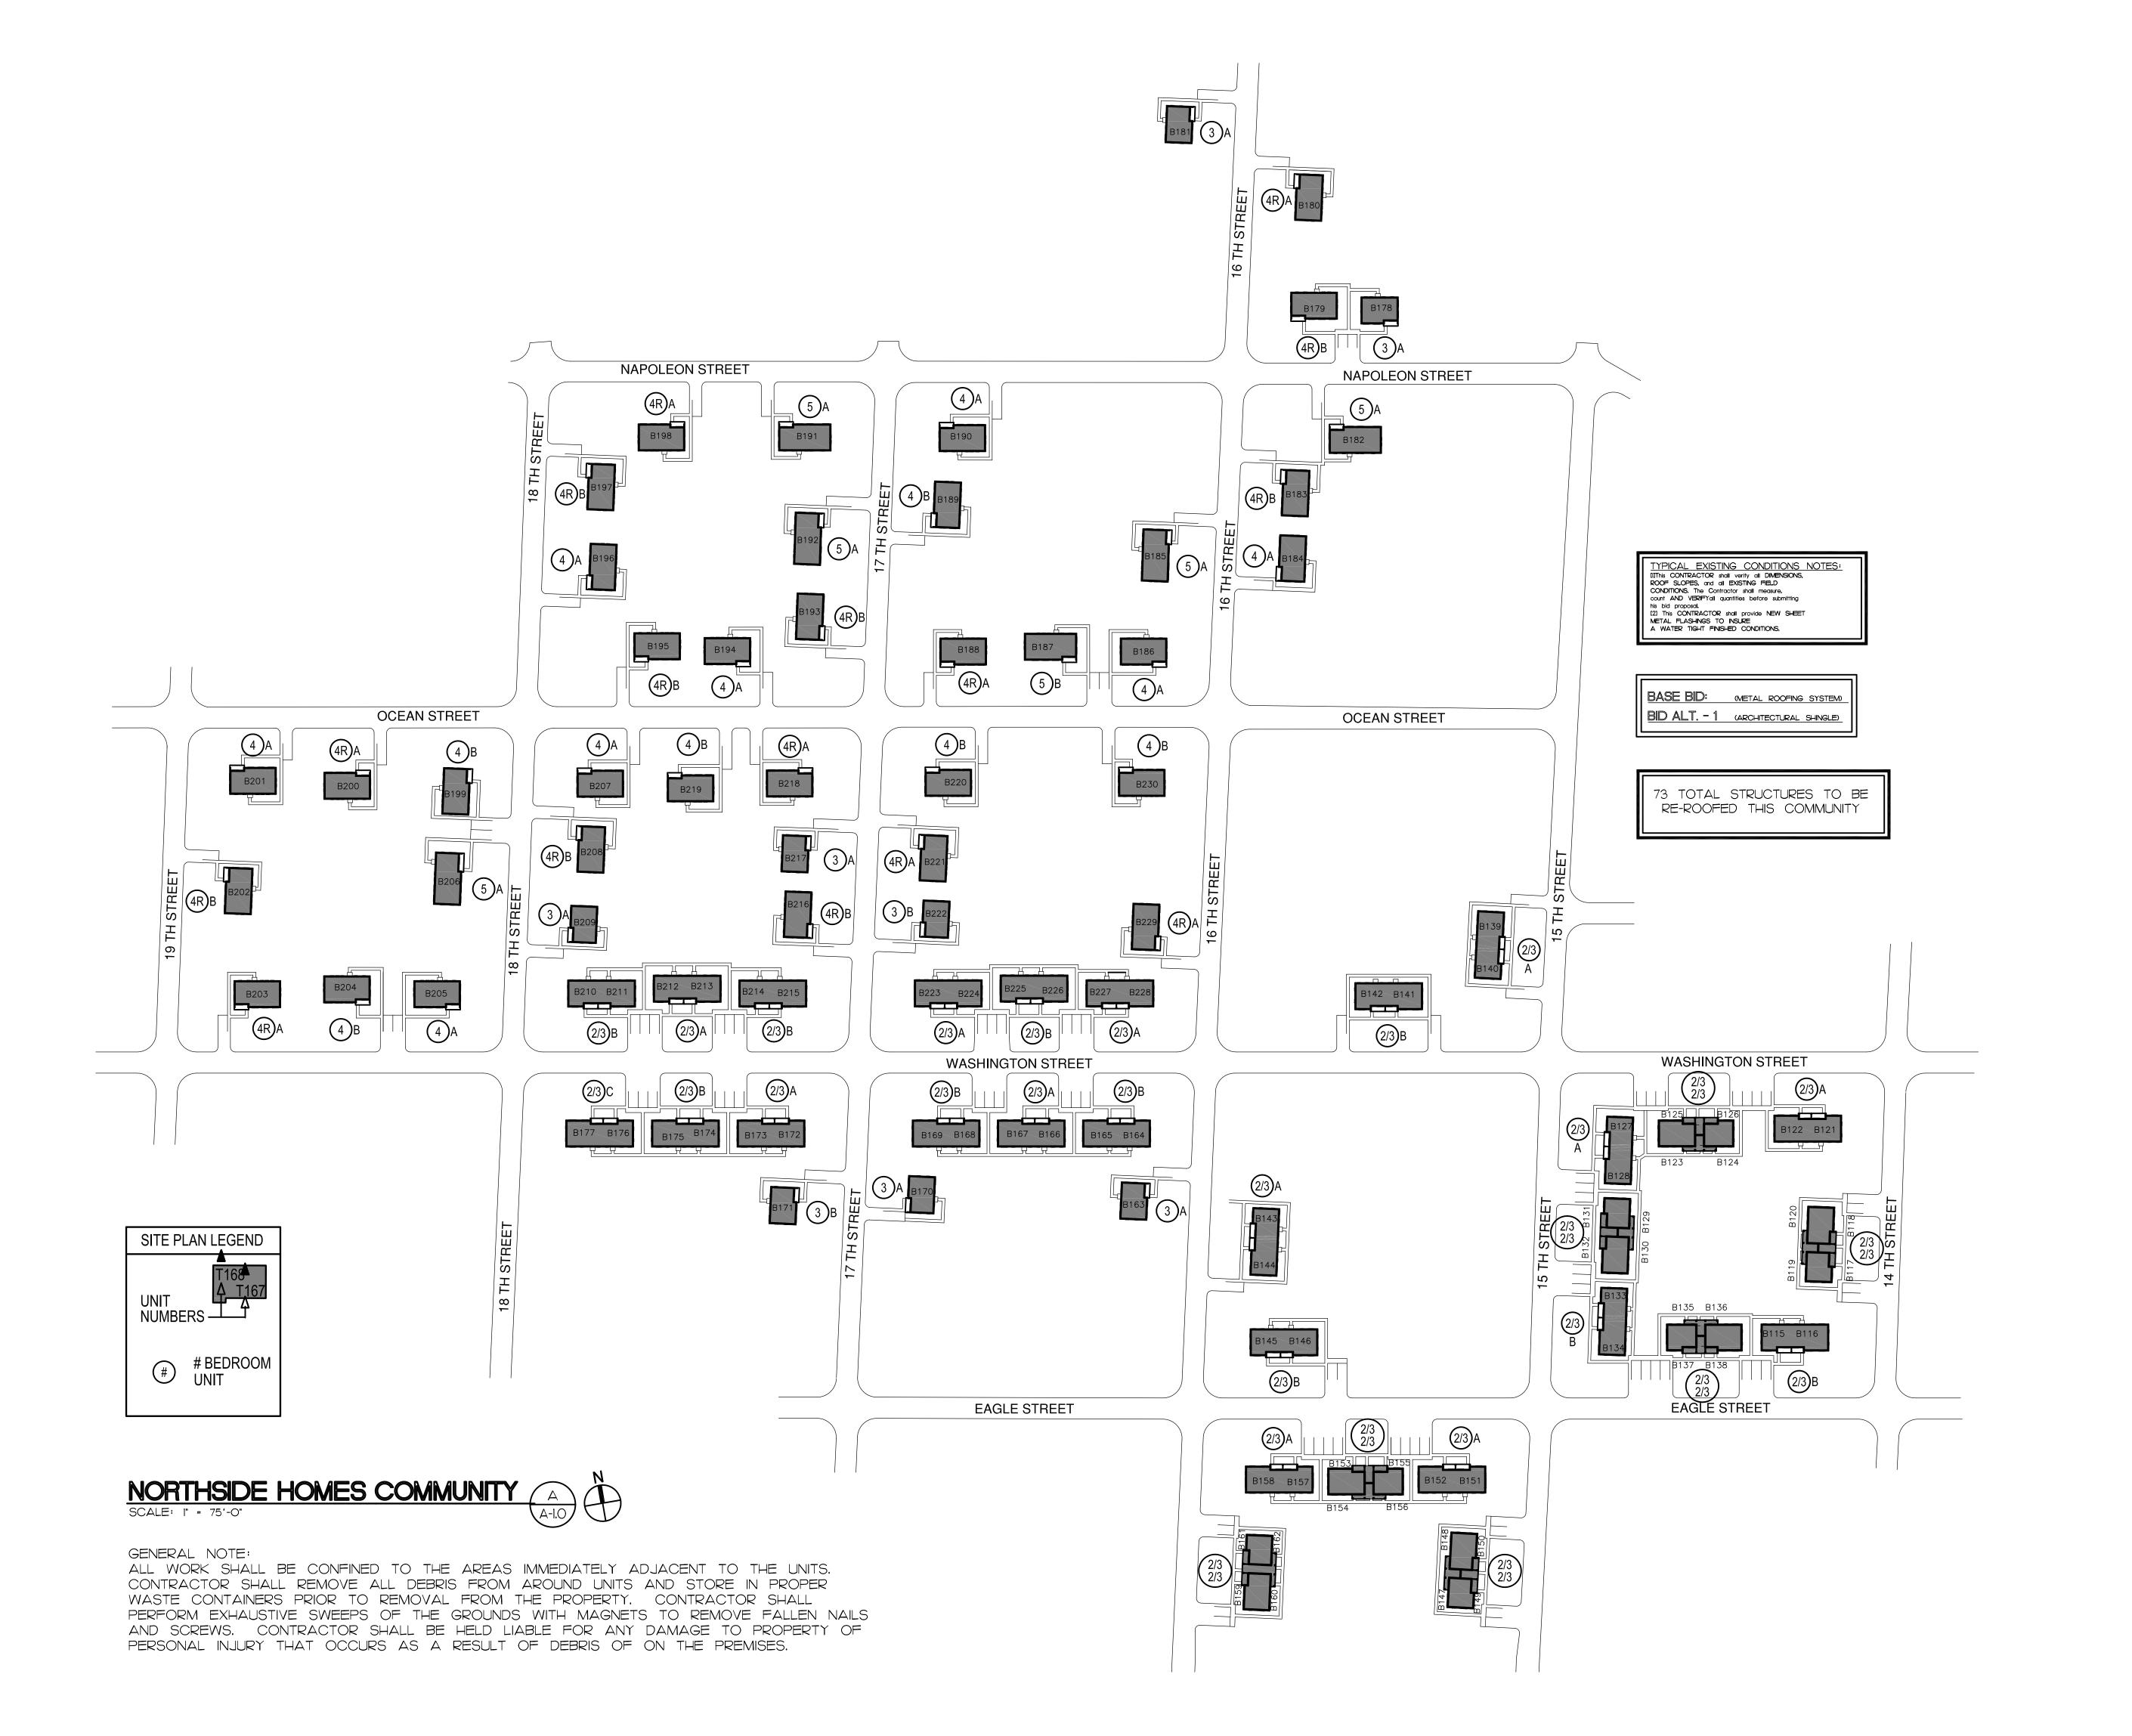


CRG ARCHITECTS
/ PALATKA, INC.
216A ST. JOHNS AVE.
PALATKA, FL 32177
A A 0 0 0 2 6 0 4
p. 386-325-0213
f. 386-328-1401 **BID SET** RE-ROOFING AT NORTHSIDE E
PALATKA HOUSING AUTHOF
PALATKA, FL.


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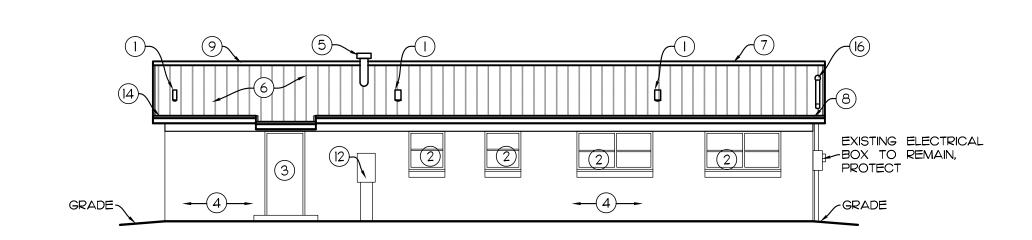
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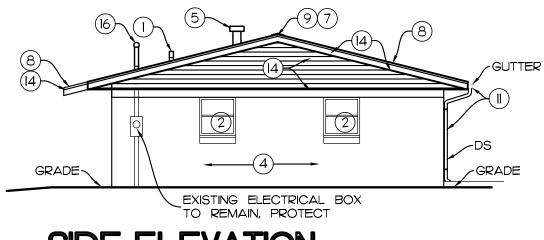
ROOF PLAN SCALE: 1/8" = 1'-0"



FRONT ELEVATION

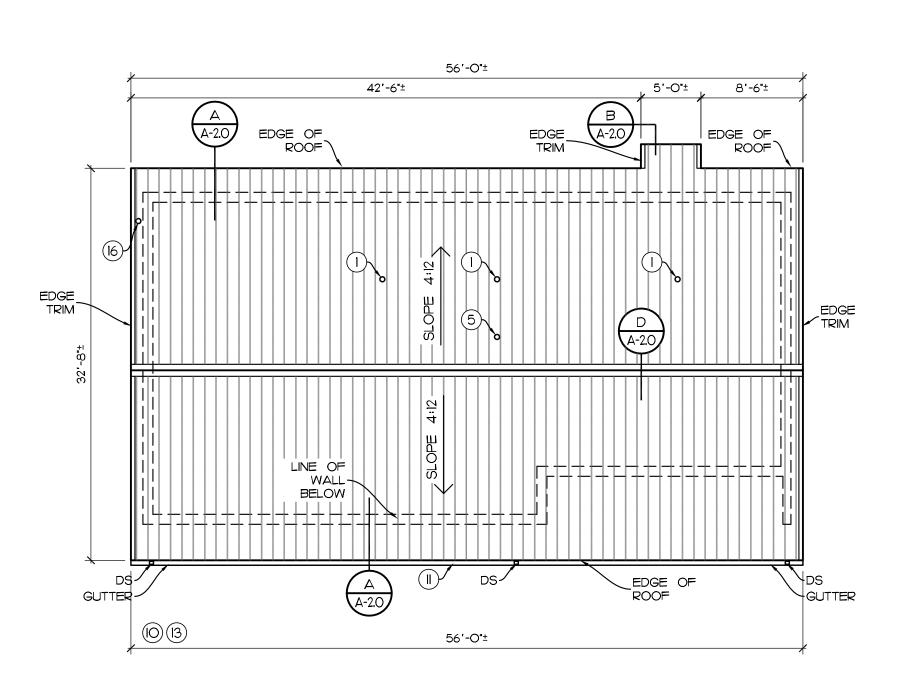


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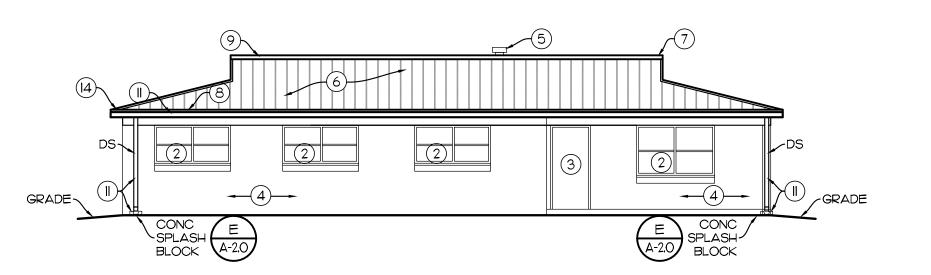

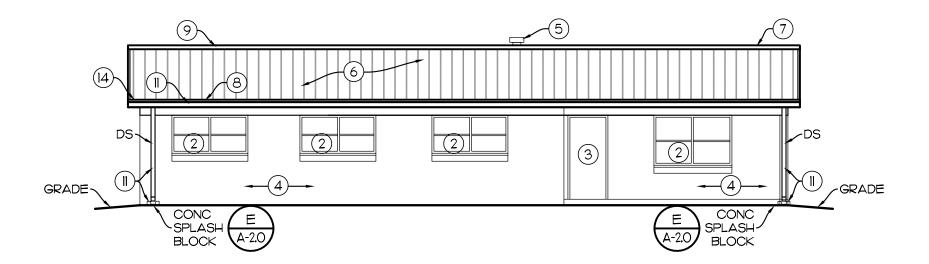
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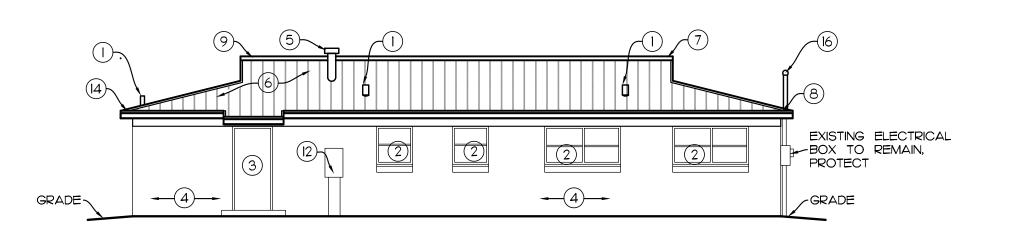
BUILDING TYPE (5A)




ROOF PLAN 2 SCALE: 1/8" = 1'-0" A-1.1

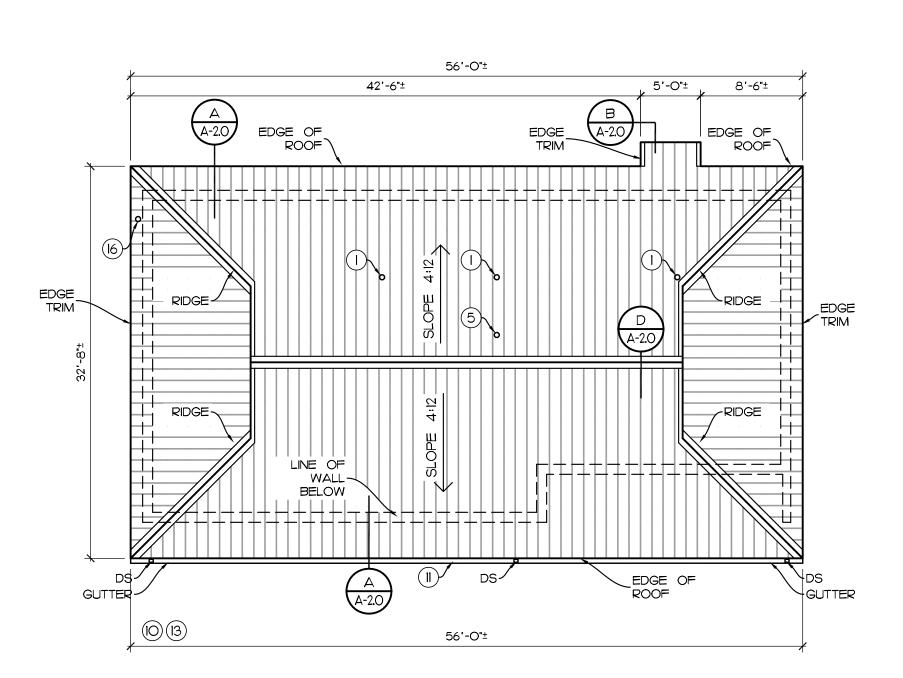


FRONT ELEVATION




REAR ELEVATION SCALE: 1/8" = 1'-0"

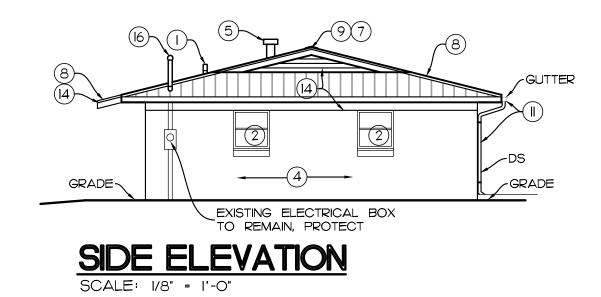


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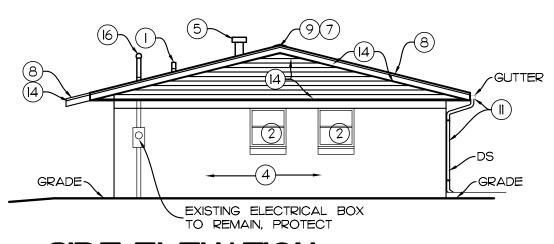


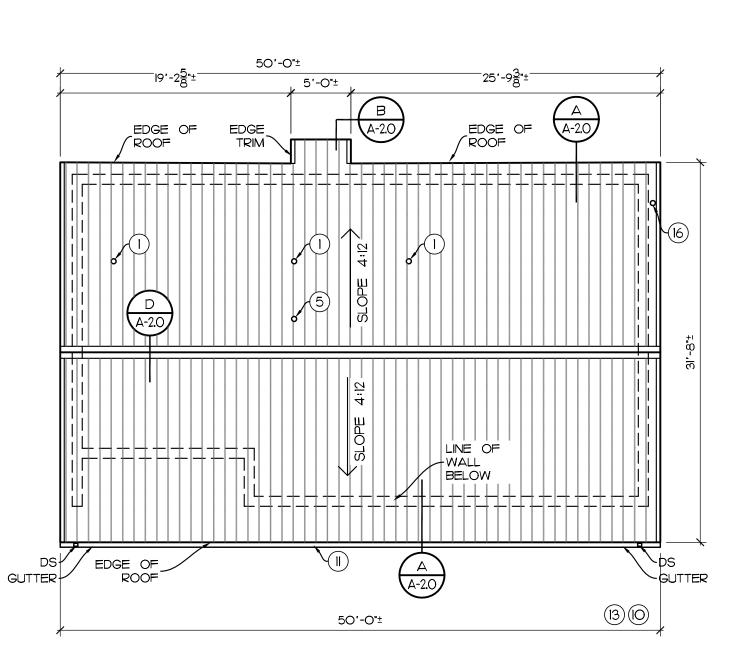

FRONT ELEVATION

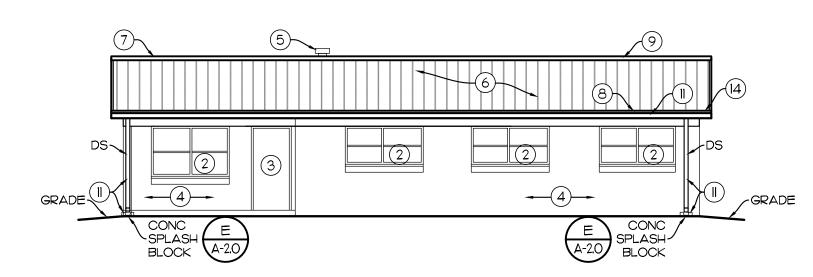

REAR ELEVATION SCALE: 1/8" = 1'-0"

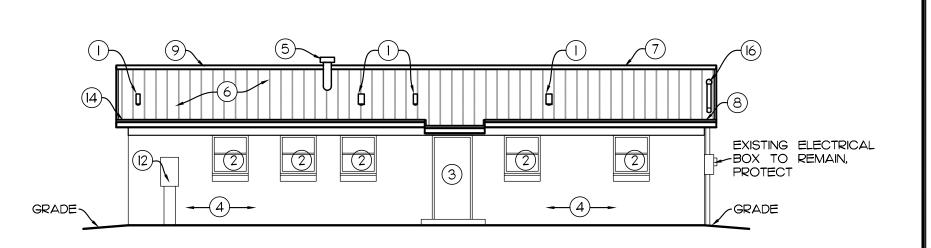

SCALE: 1/8" = 1'-0"

BUILDING TYPE (4A)

CRG ARCHITECTS
/ PALATKA, INC.
216A ST. JOHNS AVE.
PALATKA, FL 32177
A A 0 0 0 2 6 0 4
p. 386-325-0213
f. 386-328-1401


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RE-ROOFING AT NORTHSIDE HOMES PALATKA HOUSING AUTHORITY PALATKA, FL.


Seal/Signature:

Scale: AS NOTED JCK Drawn:


Ol6ZO3

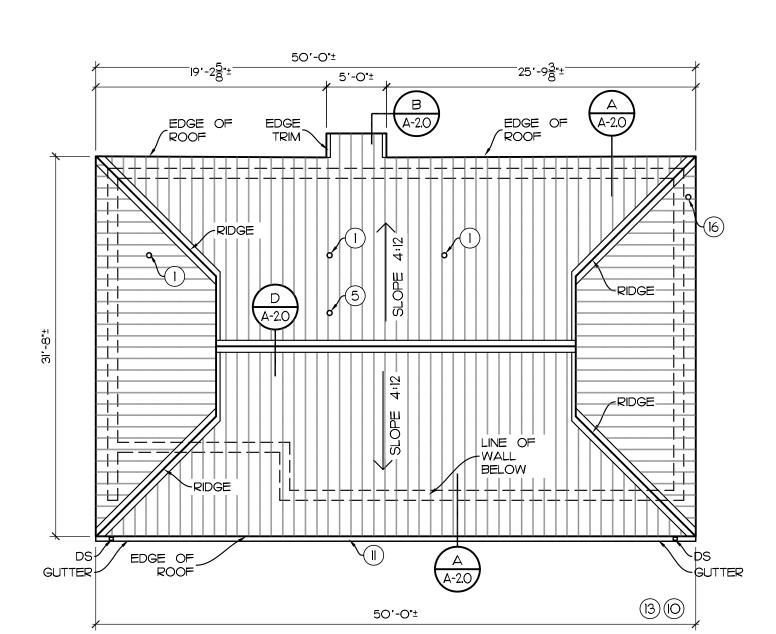


ROOF PLAN SCALE: 1/8" = 1'-0"

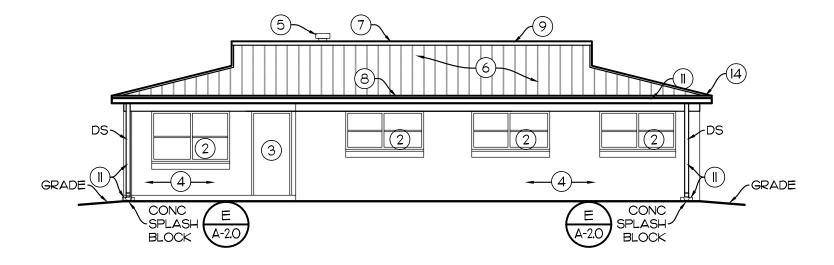

FRONT ELEVATION

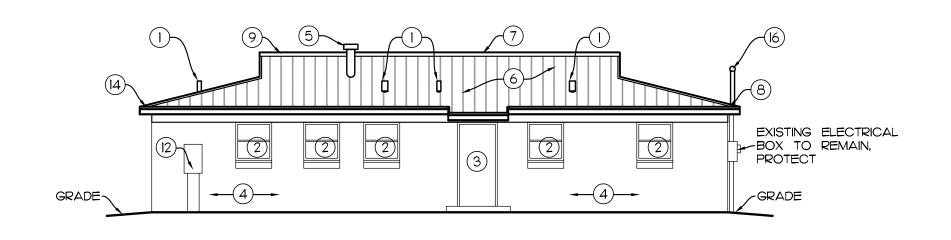


REAR ELEVATION SCALE: 1/8" = 1'-0"

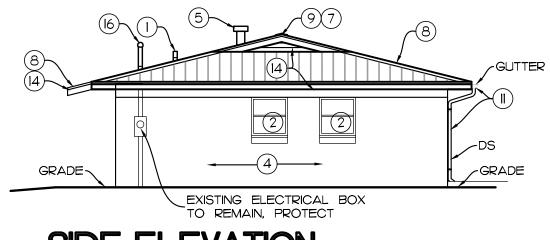


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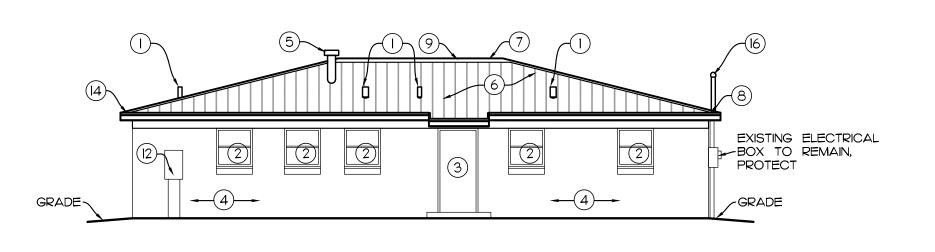
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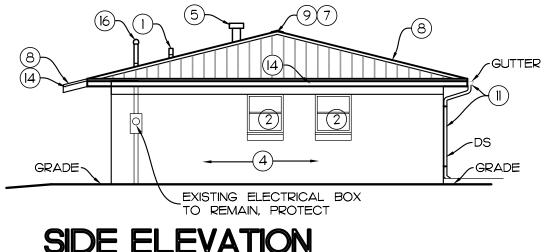
ROOF PLAN 2 SCALE: 1/8" = 1'-0" A-1.2

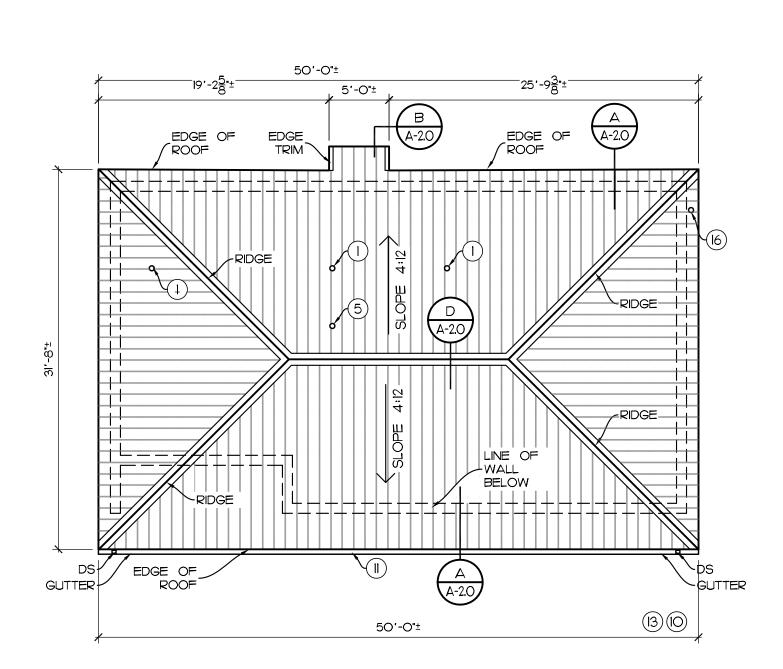

FRONT ELEVATION

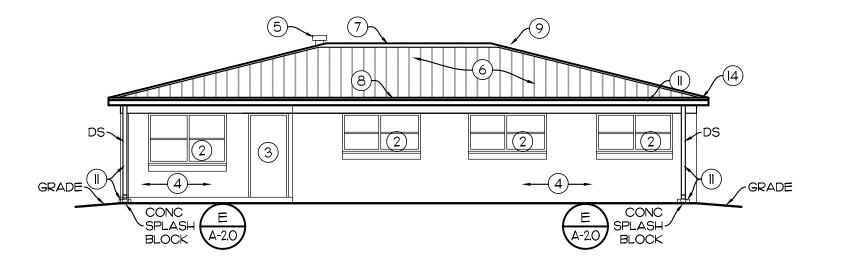


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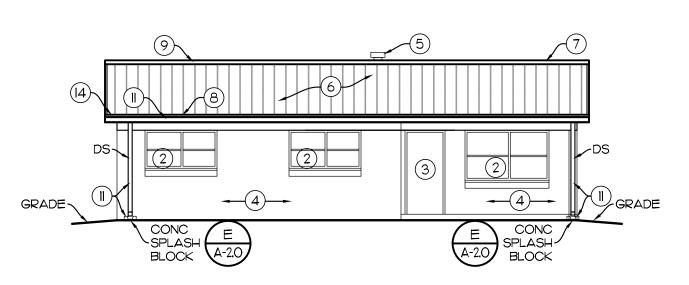


SCALE: 1/8" = 1'-0"


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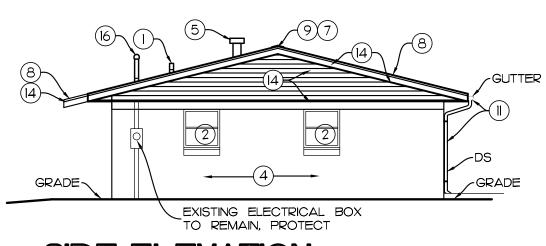


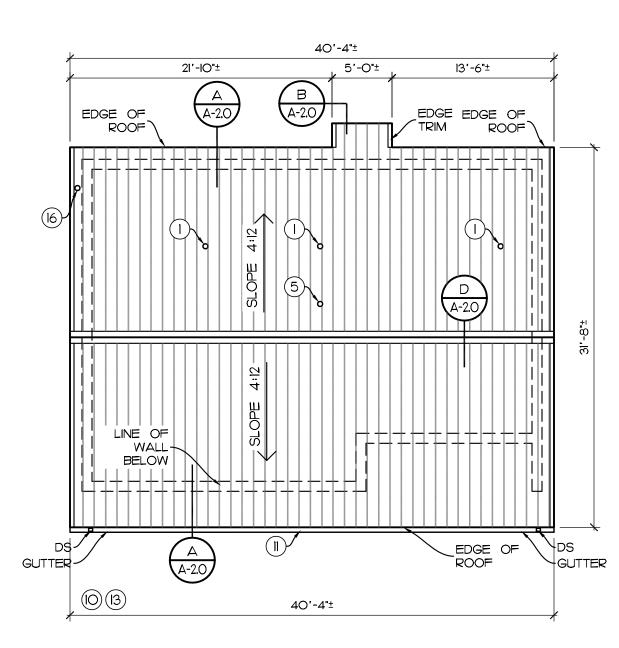

FRONT ELEVATION



REAR ELEVATION SCALE: 1/8" = 1'-0"

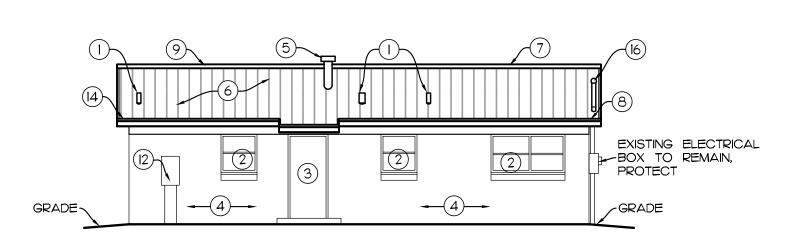

SCALE: 1/8" = 1'-0"

BUILDING TYPE (3A)


CRG ARCHITECTS
/ PALATKA, INC.
216A ST. JOHNS AVE.
PALATKA, FL 32177
A A 0 0 0 2 6 0 4
p. 386-325-0213
f. 386-328-1401

BID SET


RE-ROOFING AT NORTHSIDE HOMES PALATKA HOUSING AUTHORITY PALATKA, FL.

Seal/Signature:


Scale: AS NOTED JCK Drawn: Ol6ZO3

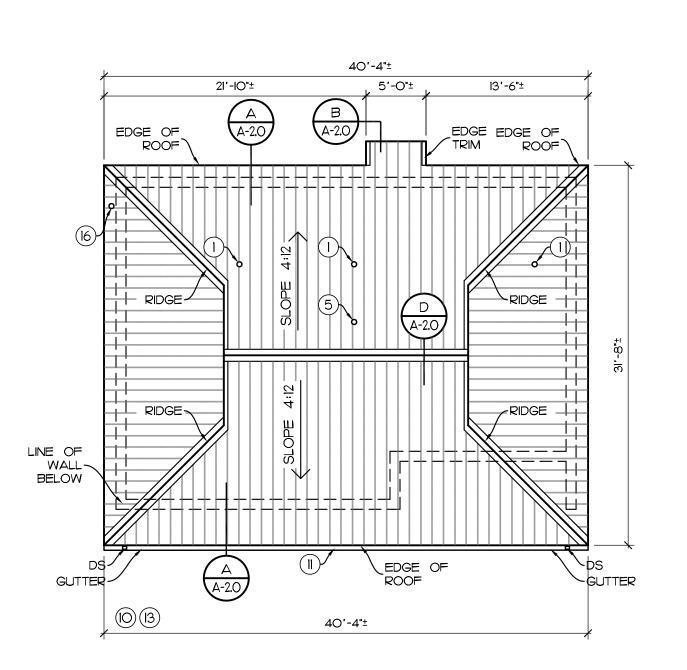




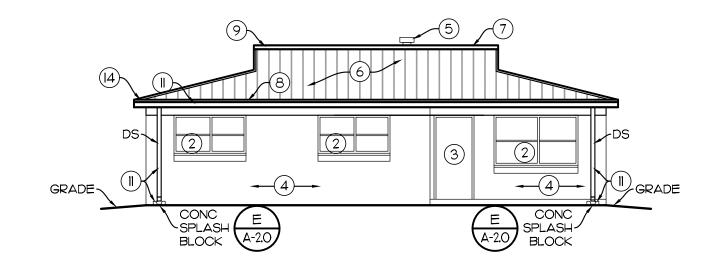


FRONT ELEVATION

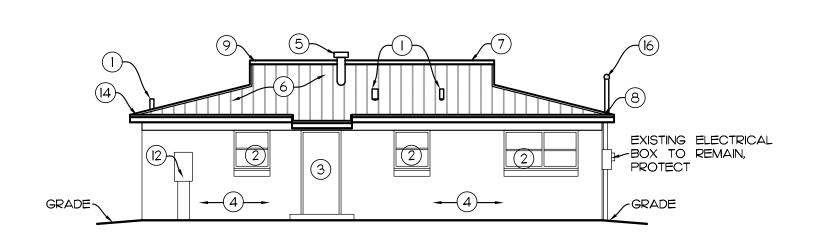


REAR ELEVATION SCALE: 1/8" = 1'-0"

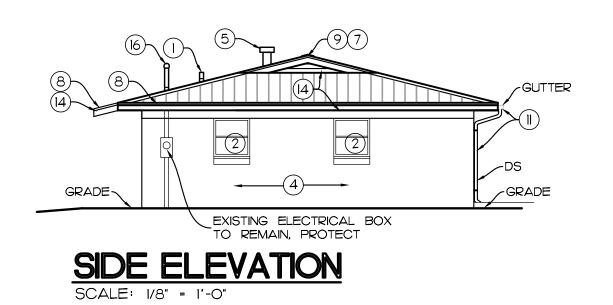


BUILDING TYPE (3B)

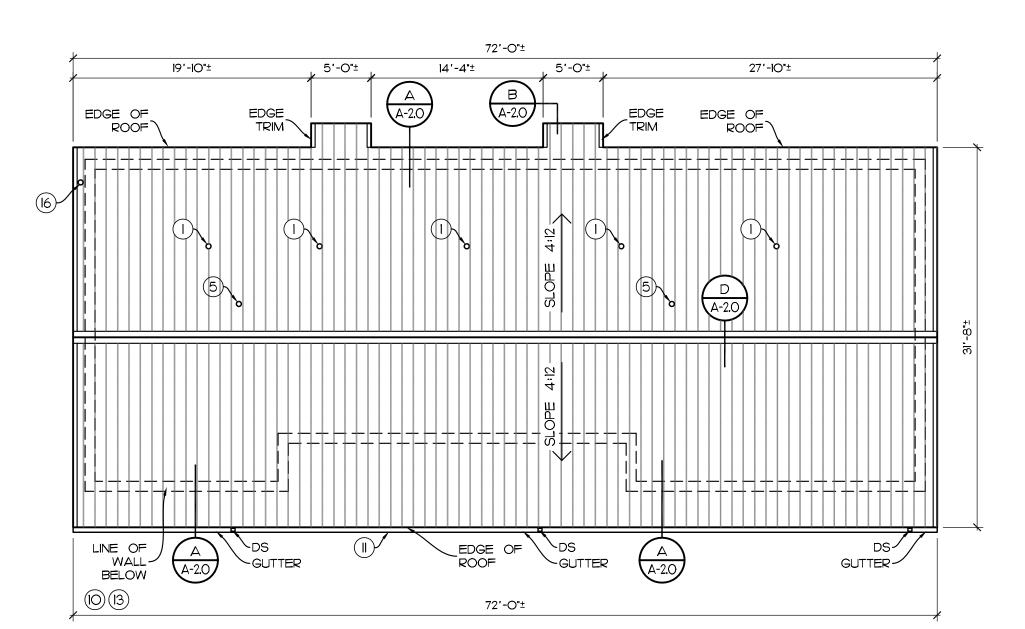


ROOF PLAN 2 SCALE: I/8" = I'-O" A-I.3

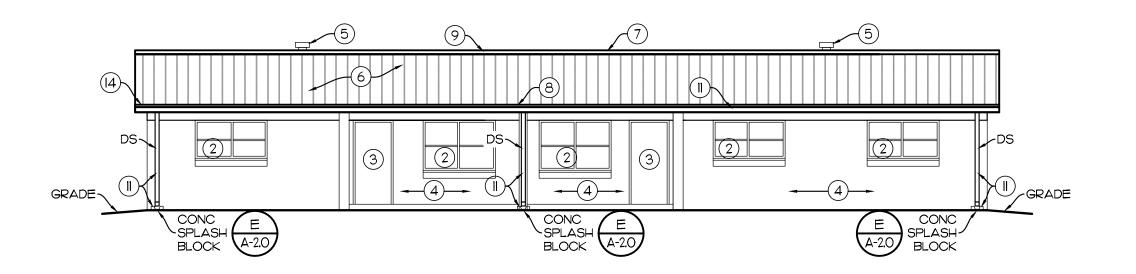


FRONT ELEVATION

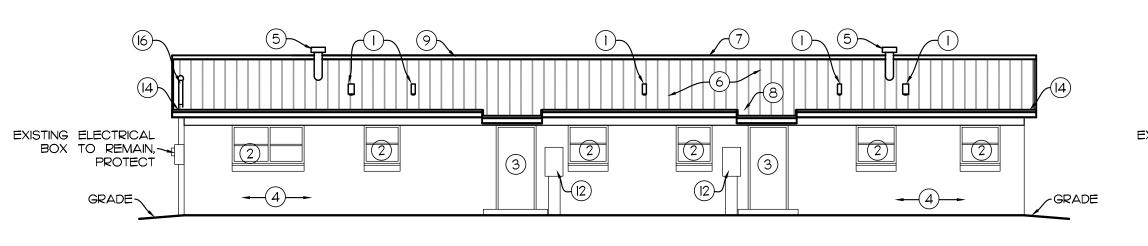


REAR ELEVATION SCALE: 1/8" = 1'-0"

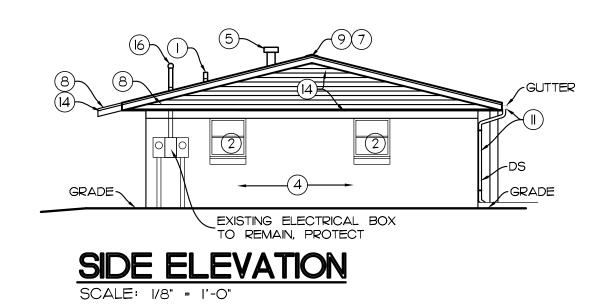


BUILDING TYPE (2/3 A)

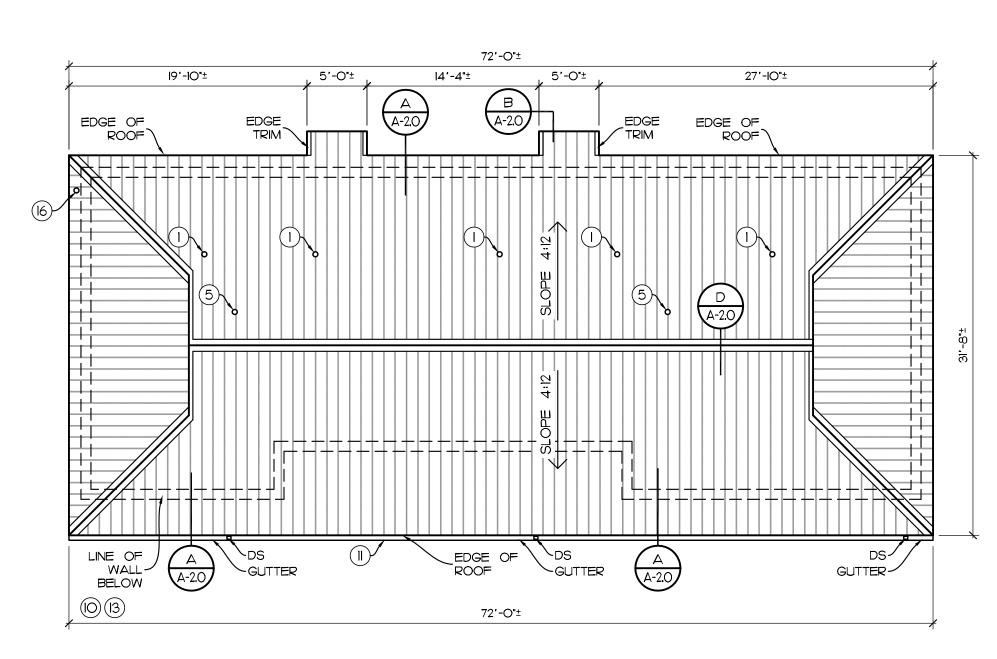




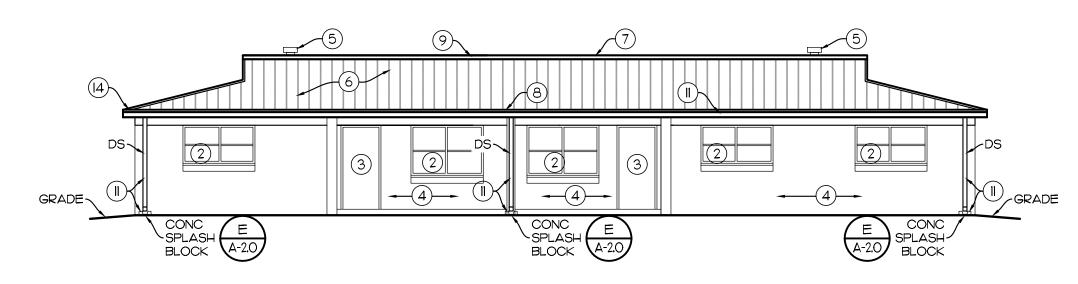

FRONT ELEVATION

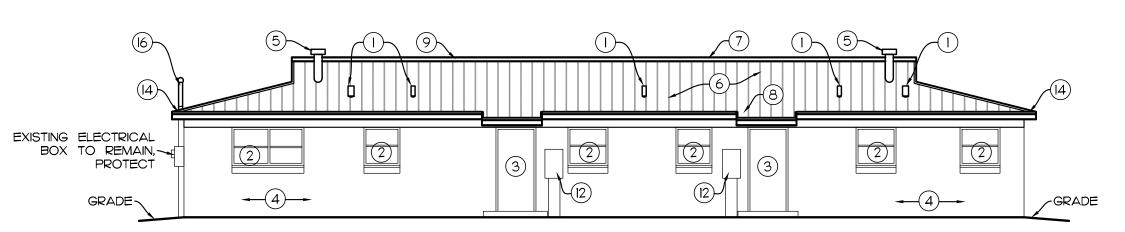

REAR ELEVATION SCALE: 1/8" = 1'-0"

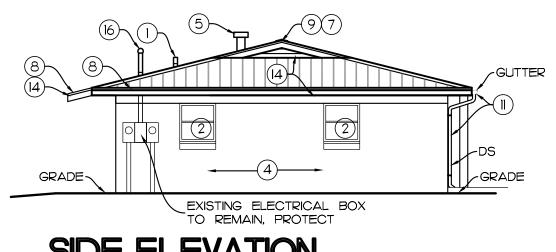

SCALE: 1/8" = 1'-0"

BUILDING TYPE (2/3 B)

CRG ARCHITECTS
/ PALATKA, INC.
216A ST. JOHNS AVE.
PALATKA, FL 32177
A A 0 0 0 2 6 0 4
p. 386-325-0213
f. 386-328-1401


BID SET

RE-ROOFING AT NORTHSIDE HOMES
PALATKA HOUSING AUTHORITY
PALATKA, FL.

Seal/Signature:

AS NOTED Drawn: JCK Ol6ZO3

A-1.3

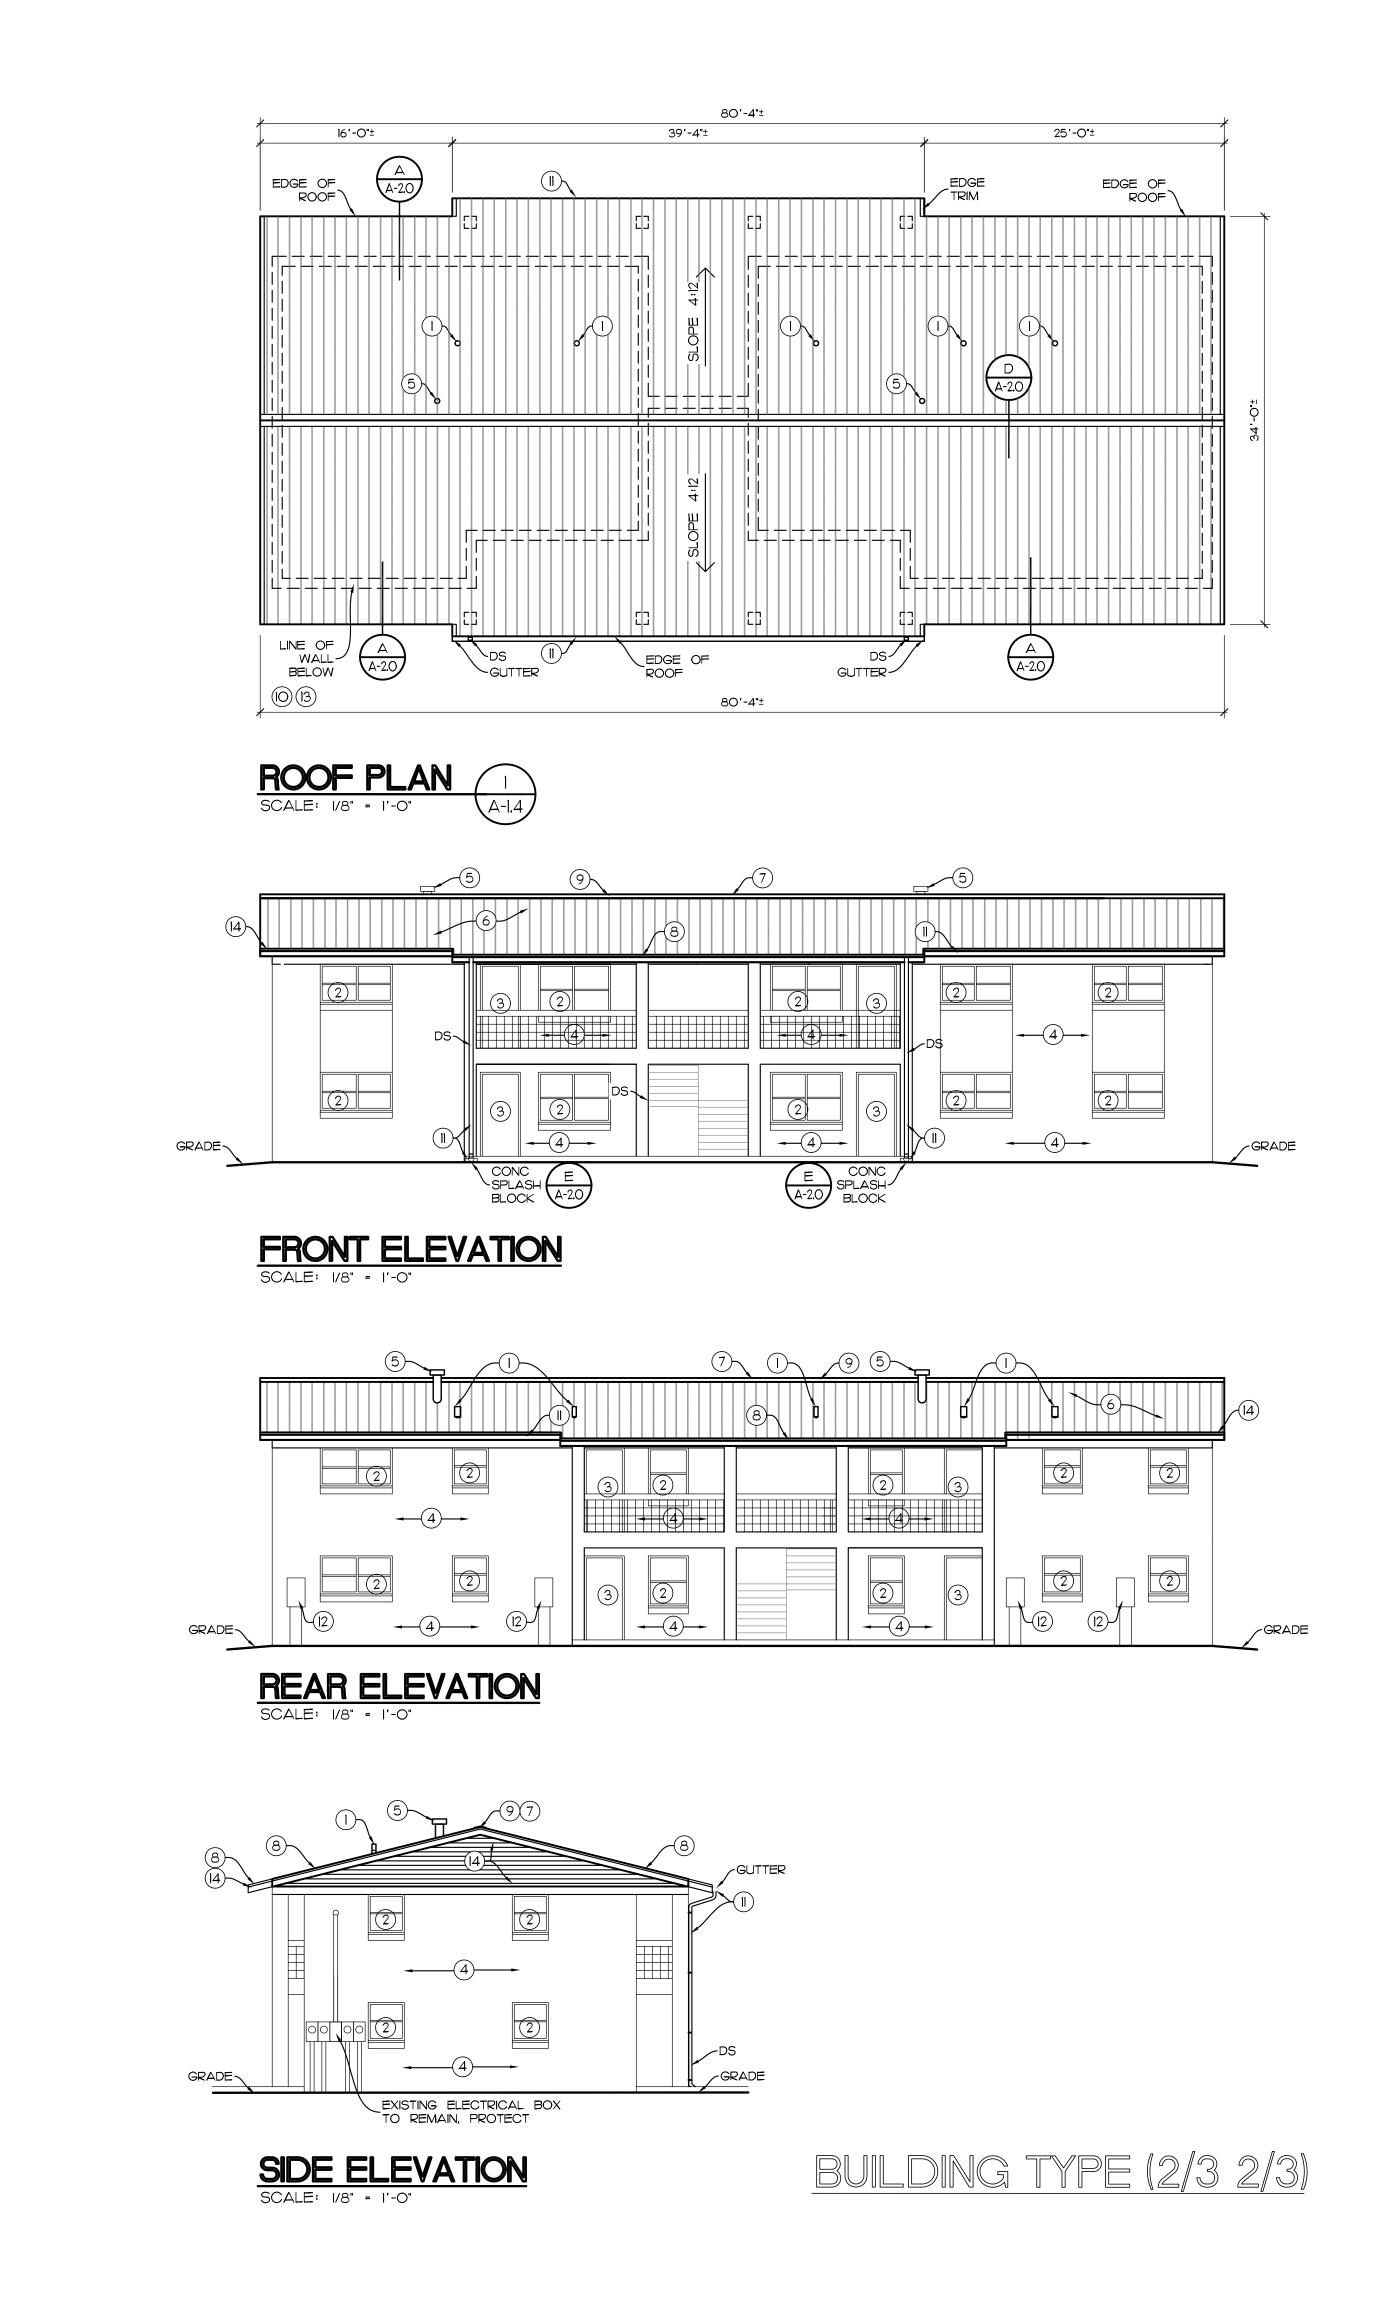

CRG ARCHITECTS
/ PALATKA, INC.
216A ST. JOHNS AVE.
PALATKA, FL 32177
A A 0 0 0 2 6 0 4
p. 386-325-0213
f. 386-328-1401 BID SET

RE-ROOFING AT NORTHSIDE HOMES PALATKA HOUSING AUTHORITY PALATKA, FL.


Seal/Signature:


AS NOTED

JCK Drawn: Ol6ZO3

A-1.4

7 Of 8 Sheets

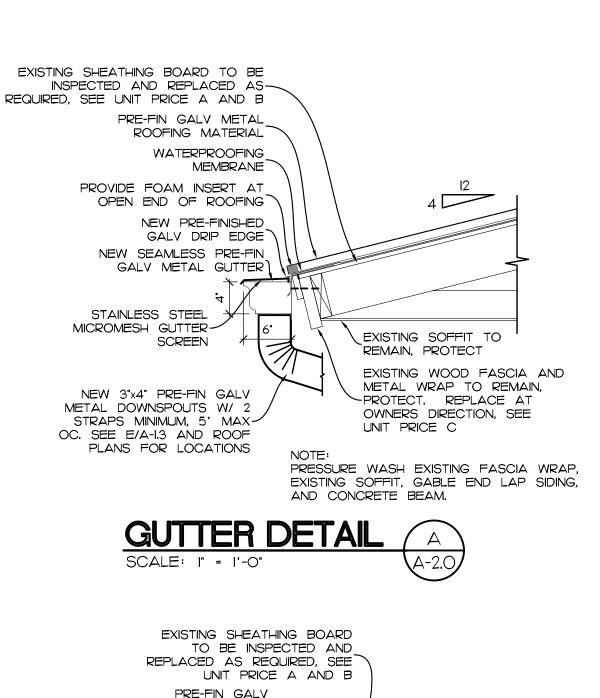

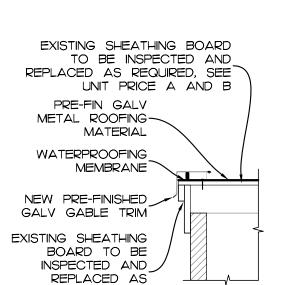


REQUIRED, SEE UNIT


PRICE A AND B

NOTE:
PRESSURE WASH EXISTING FASCIA WRAP,
EXISTING SOFFIT, GABLE END LAP SIDING,
AND CONCRETE BEAM.



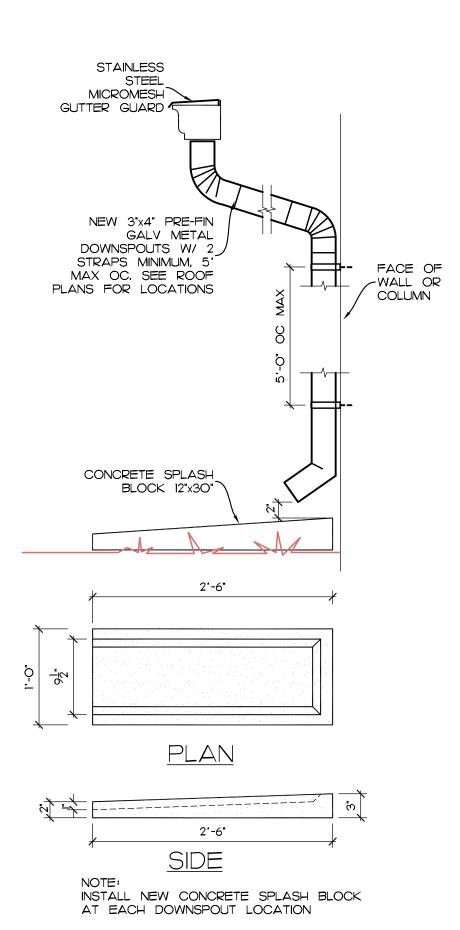




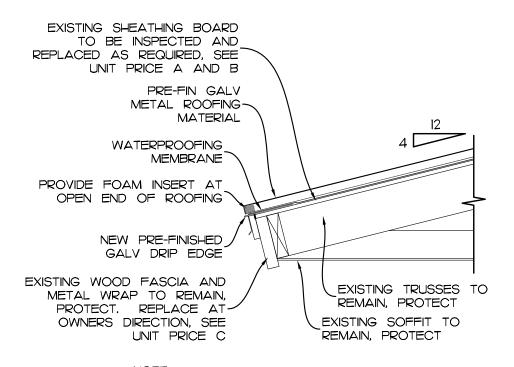



NOTE:
PRESSURE WASH EXISTING FASCIA WRAP,
EXISTING SOFFIT, GABLE END LAP SIDING,
AND CONCRETE BEAM.



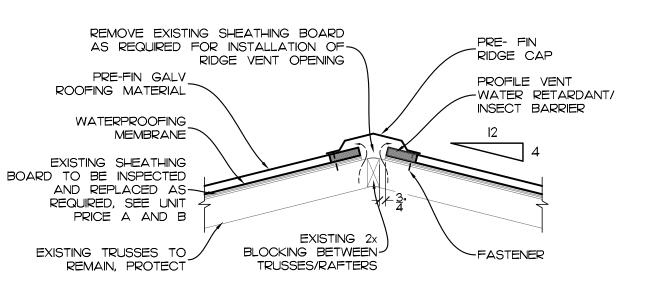



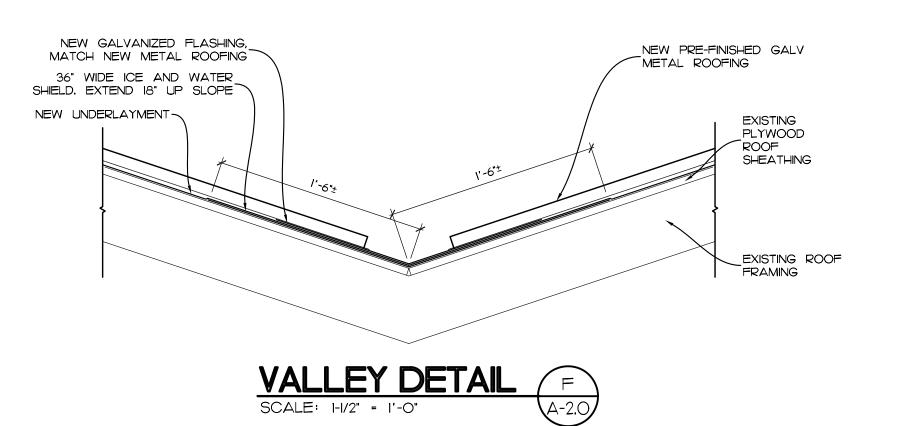

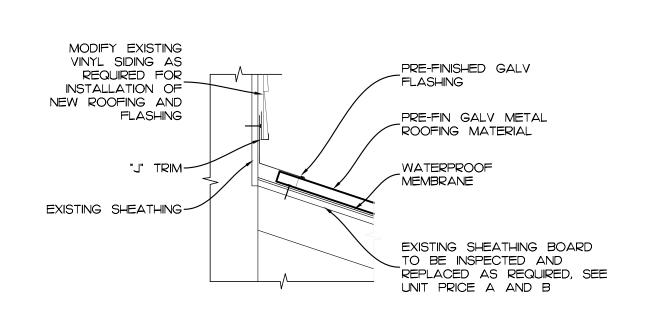



SCOPE OF WORK

BASE BID PROJECT

REMOVE EXISTING SHINGLE ROOFING AND FELT UNDERLAYMENT, REMOVE EXISTING METAL DRIP EDGE AND EXISTING LEAD FLASHING BOOTS. REPLACE ALL DAMAGED SHEATHING BOARD (SEE UNIT PRICES I AND 2 WITH LIKE MATERIAL. PREP SHEATHING BOARD TO RECEIVE NEW WATERPROOFING MEMBRANE, NEW METAL DRIP EDGE, NEW FLASHING BOOTS AT ALL ROOF PENETRATIONS AND NEW METAL ROOFING SYSTEM. PROVIDE NEW CONTINUOUS RIDGE VENT, MODIFYING THE EXISTING SHEATHING BOARD AS REQUIRED. ALL ROOFING INSTALLATION SHALL STRICTLY ADHERE TO THE MANUFACTURERS REQUIREMENTS AND RECOMMENDATIONS.

UNIT PRICE NOTE

CONTRACTOR SHALL INCLUDE IN THEIR BID PROPOSAL UNIT PRICE FOR THE REMOVAL AND REPLACEMENT OF DETERIORATED AND/OR DAMAGED PLYWOOD SHEATHING, NEW PLYWOOD SHEATHING SHALL MATCH EXISTING THICKNESS, SHEATHING SHALL BE NAILED IN STRICT ACCORDANCE WITH THE FLORIDA BUILDING CODE. (CURRENT ADDITIONS). TWO UNIT COSTS FOR PLYWOOD SHEATHING SHALL BE PROVIDED:

A. 1/2" PLYWOOD SHEATHING B. 5/8" PLYWOOD SHEATHING

OWNER SHALL VERIFY AND APPROVE QUANTITY OF WORK TO BE DONE.

C. REMOVE EXISTING METAL WRAP OVER EXISTING WOOD EAVE AT PERIMETER OF ROOF. REPLACE ANY ROTTEN WOODEN FASCIA, AND PREP TO RECEIVE NEW METAL FASCIA WRAP. ALUMINUM METAL FASCIA SHALL BE COATED ON BOTH SIDES WITH A HIGH PERFORMANCE PAINT SYSTEM. COLOR SHALL BE SELECTED BY ARCHITECT FROM MANUFACTURER STANDARD COLORS. METAL SHALL BE .024" THICK ALUMINUM. PROVIDE PRICE PER UNIT.

GENERAL NOTES

- EXISTING PLUMBING VENT. PROVIDE NEW BOOTS, FIELD VERIFY
 NUMBER AND LOCATIONS, EXTEND PLUMBING VENT AS REQUIRED
 TO OBTAIN 8" OF RISE ABOVE NEW ROOF
- (2) EXISTING WINDOWS (PROTECT)
- (3) EXISTING DOORS (PROTECT)
- (4) EXISTING BRICK (PROTECT)
- 5 EXISTING EXHAUST FLUE. INSTALL NEW THERMAL RATED BOOTS AND CAPS. FIELD VERIFY NUMBER AND LOCATIONS
- 6 PROVIDE NEW METAL ROOFING. SEE BASE BID AND SPECIFICATIONS
- 7) RIDGE VENT, CONTINUOUS (MATCH ROOFING MATERIAL)
- (8) NEW METAL DRIP (BASE BID)
- TRIM EXISTING ROOF SHEATHING (AS REQUIRED) AND PROVIDE AND INSTALL CONTINUOUS RIDGE VENT. RIDGE VENT SHALL BE APPROPRIATE FOR THE ROOFING SYSTEM USED (SEE SPECIFICATIONS)
- (IO) EXISTING COLUMN TO REMAIN, PROTECT
- DEMO/REMOVE EXISTING GUTTERS AND DOWNSPOUTS (AND PVC DOWNSPOUTS) AND REPLACE WITH NEW GUTTERS, DOWNSPOUTS AND SPLASH BLOCKS. LENGTH OF GUTTER IS INDICATED ON THE DRAWINGS. PROVIDE GUTTER GUARDS WITH STAINLESS STEEL MICROMESH COVER ON ALL GUTTERS. GUTTER GUARD BASIS OF DESIGN WWW.LEAFFILTER.COM
- (12) EXISTING GAS WATER HEATER TO REMAIN, PROTECT.
- EXISTING TV SATELLITE DISH TO REMAIN, PROTECT (FIELD VERIFY ALL LOCATIONS). CONTRACTOR SHALL WORK AROUND EXISTING TV SATELLITE DISH. UNINSTALL AS REQUIRED FOR INSTALLATION OF ROOF PANELS. DO NOT NOTCH END OF ROOF PANS TO ACCOMMODATE EXISTING SATELLITE DISH.
- PRESSURE WASH EXISTING FASCIA SCHEDULED TO REMAIN, EXISTING SOFFIT, AND EXISTING LAP SIDING AND VENT ON GABLE ENDS. PRESSURE WASH EXISTING CONCRETE TIE BEAM AT TOP OF WALL. PROTECT ALL EXISTING EXTERIOR LIGHT FIXTURES, WATER HEATERS, PLUMBING, TELEPHONE CABLES, COAXIAL CABLES, ETC...
- EXISTING EXHAUST DUCT ROOF CAP, MODIFY AND EXTEND VENT 8"
 ABOVE ROOF DECK. PROVIDE NEW FLASHING/WATERPROOFING.
 INSTALL EXISTING VENT CAP ON EXTENDED VENT DUCTS,
- (6) EXISTING ELECTRICAL WEATHER HEAD, PROTECT. PROVIDE NEW BOOT. FIELD VERIFY LOCATION

GENERAL ROOFING NOTES

- I. IF VENT PIPES, PLUMBING WASTE AND/OR HEATER FLUE NEED TO BE OFFSET FOR ANY REASON THE OFFSET MAY BE NO MORE THAN 2" (OR DIA OF PIPE) WITH NO MORE THAN A "1/8 BEND"
- 2. ALL FLUES / ROOF PENETRATIONS MUST BE VERTICAL (PLUMB IN BOTH DIRECTIONS) AT THE END OF THE PROJECT AND AT THE TIME OF THE FINAL INSPECTION. IT SHALL BE CONTRACTOR'S RESPONSIBILITY TO INSURE ALL FLUES AND VENTS ETC... ARE ATTACHED WHEN FINISHED
- 3. REATTACH ANY LOOSE FASCIA PRIOR TO INSTALLATION OF NEW DRIP AND RAKE TRIM. REMOVE AND REINSTALL EXISTING FASCIA WRAP AS REQUIRED TO ATTACH FASCIA. FASCIA AND RAKE TRIM ATTACHMENT TO BE CONCEALED BY NEW RAKE TRIM/DRIP EDGE.
- 4. THE HORIZONTAL DIMENSIONS SHOWN ON ROOF PLANS ARE FROM FACE OF FASCIA TO FACE OF FASCIA AND ARE FOR GENERAL USE ONLY. THE ARCHITECT DOES NOT GUARANTEE THE ACCURACY OF THESE EXISTING BUILDING DIMENSIONS SHOWN. THE CONTRACTOR IS RESPONSIBLE TO VERIFY ALL THE EXISTING BUILDING DIMENSIONS, CONDITIONS AND QUANTITIES BEFORE THE BID DATE AND BASE THEIR BID ON THEIR ACTUAL FIELD DIMENSIONS, CONDITIONS AND QUANTITIES.
- 5. CONTRACTOR SHALL FIELD VERIFY ROOF SLOPE PRIOR TO BID DATE AND/OR ORDERING ANY MATERIALS
- 6. CONTRACTOR SHALL FIELD VERIFY/LOCATE ELECTRICAL MAST AND WIRING AT ALL BUILDINGS AND PROTECT DURING CONSTRUCTION.
- 7. CONTRACTOR SHALL FIELD VERIFY/LOCATE SATELLITE DISH(ES)
 ATTACHED TO THE BUILDING VIA MOUNTING POST OR BY OTHER
 MEANS AT ALL BUILDINGS AND PROTECT DURING CONSTRUCTION.
- 8. CONTRACTOR SHALL REPAIR ALL AREAS OF THE SITE DAMAGED DURING CONSTRUCTION INCLUDING BUT NOT LIMITED TO RUTS, GRASS, CONCRETE, FENCING, ETC....... AND BRING TO LIKE NEW CONDITION
- 9. CONTRACTOR SHALL POLICE GROUNDS AROUND EACH HOUSING UNIT ξ REMOVE ALL CONSTRUCTION DEBRIS INCLUDING NAILS ξ SCREWS.

REVISION

CRG

CRG ARCHITECTS
/ PALATKA, INC.
216A ST. JOHNS AVE.
PALATKA, FL 32177
A A 0 0 0 2 6 0 4
p. 386-325-0213

BID SET

f. 386-328-1401

ROOFING DETAILS

RE-ROOFING AT NORTHSIDE HOME PALATKA HOUSING AUTHORITY PALATKA, FL.

Seal/Signature:

Date: 1-6-25

Scale: AS NOTED

Drawn: JCK

Job: 016Z03

A-2.0